


VEDERE IN PLAN scara 1:50

PLAN VIEW scale 1:50

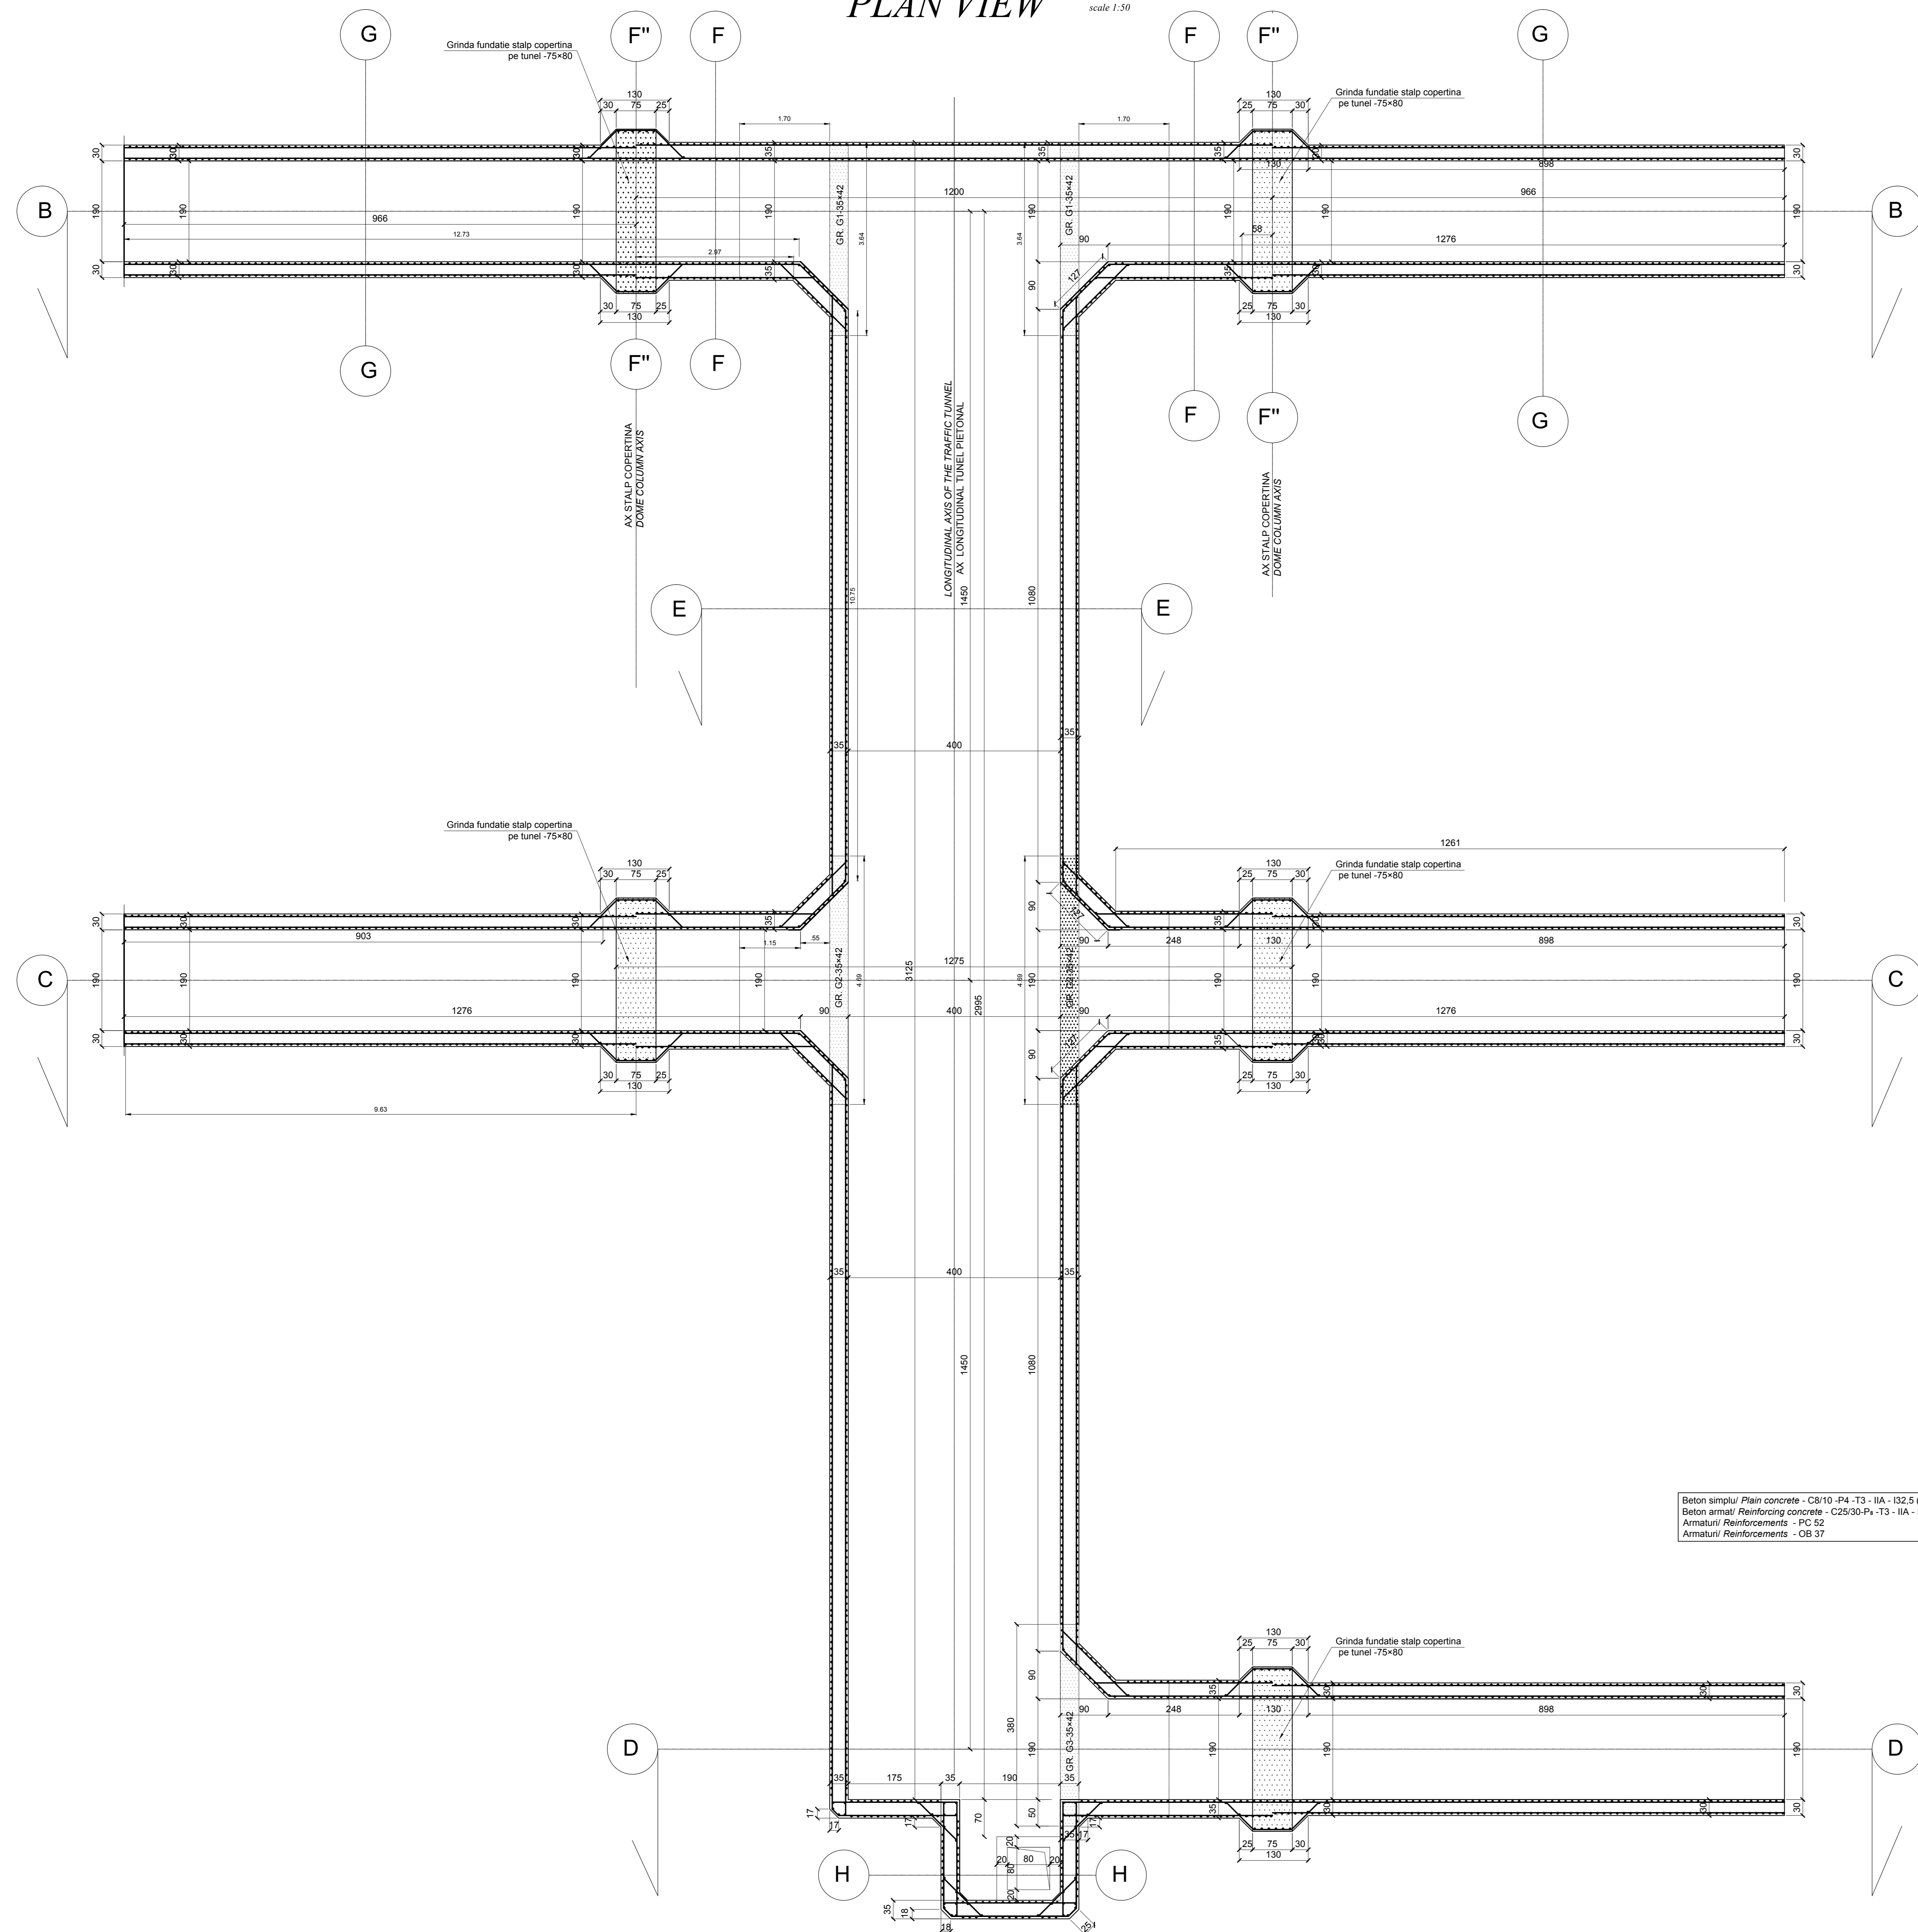

MARGA	Ø	Nr buc	Lung pe diametru	LUNGIMI PE DIAMETRE					
				6	10	10	12	16	20
	20	82	3.30						434.60
	20	82	5.30						451.00
	20	164	7.70						1262.80
	4	82	5.30						451.00
	6	16	82	5.30					434.60
	6	16	132	7.30					1206.00
	7	16	128	4.20					722.40
	8	16	132	4.00					688.00
	9	12	220	3.65				803.00	
	10	12	145	3.05				442.25	
	11	12	30	4.30				136.00	
	107	12	15	3.80				57.00	
	11	12	90	3.15				283.50	
	111	12	15	3.30				84.50	
	12	12	305	4.90				1494.50	
	13	12	319	4.00				1276.00	
	14	16	30	4.00				120.00	
	15	16	30	2.30				87.00	
	16	20	55	3.70					203.50
	17	16	50	3.40				170.00	
	18	16	60	4.65				279.00	
	19	16	60	5.35				321.00	
	20	60	4.35					261.00	
	21	10	100	2.60	416.00				
	21	10	240	2.75	660.00				
	22	10	60	1.40	72.00				
	23	10	40	3.10	124.00				
	24	12	423	3.20				1353.60	
	25	12	423	3.70				1565.10	
	26	12	290	3.50				1015.00	
	27	12	290	2.90				841.00	
	28	20	32	9.00				288.00	
	29	20	32	9.30				316.80	
	30	10	65	5.25			341.25		
	31	10	65	6.60			429.00		
	32	10	65	5.55			360.75		
	33	10	65	5.55			277.50		
	34	10	26	5.45			141.70		
	35	10	26	4.55			118.30		
	36	10	50	1.65			82.50		
	37	20	20	9.70				194.00	
	38	20	20	10.80			0.35	216.00	
	39	10	50	3.85	66	20	100	182.50	35
	40	10	50	3.70				185.00	
	41	20	16	5.30				84.80	
	41	10	103	1.45			149.35		
	42	20	16	4.25				68.00	
	42	20	8	4.40				35.20	
	43	10	18	30.05			540.90		
	44	10	20	26.20			564.00		
	45	10	40	5.10			204.00		
	46	10	40	4.25			170.00		
	47	20	16	7.55				120.80	
	48	20	16	2.20				33.00	
	49	20	16	8.10				129.60	
	50	20	16	8.00				128.00	
	51	20	16	8.55				136.8	
	52	16	40	4.00				184.00	
	53	20	32	4.10				131.20	
	54	12	14	3.10				51.80	
	55	12	14	4.50				63.00	
	56	12	17	2.35				39.95	
	57	12	11	2.75				30.25	
	58	12	19	2.05				38.95	
	59	12	11	3.05				33.55	
	60	16	68	4.00				272.00	
	61	10	1	8260.00			9010.00		
	62	12	473	1.44				662.20	
	63	12	308	1.20				369.60	
	64	6	685	0.40	273.00				
	65	6	685	0.35	309.75				
	66	20	100	0.35	35				
	total lungimi			681.75	1272.0	12786.75	10610.75	4829.00	4685.10
	kg / ml			0.222	0.616	0.616	0.888	1.578	2.465
	kg			129	806	7984	9422	7629	11549
	TOTAL			935				36456	

D					
C					
B					
A					
Index	Data	Modificari	Proiectant	Aprobat (Consultant)	Aprobat (CFR)
Index	Date	Modification/Revision	Designer	Approved (Consultant)	Approved (CFR)

GUVERNUL ROMANIEI ROMANIAN GOVERNMENT  
PROIECT FINANȚAT DE UNIUNEA EUROPEANĂ EUROPEAN UNION FINANCED PROJECT



CLIENT / CLIENT  
TAIFER  
Sect  
Vilcon  
OBERMEYER  
PLANCI + BETON GEM  
TECNIC  
Consulting Engineers

CONSULTANT / CONSULTANT		Data	Semnatura
Aprobat / Approved	Șef proiect / Project manager	12.2011	R. Luizza
Aprobat / Approved	Coordonator Secțiune 1 / Section 1 Coordinator	12.2011	C. Gambelli
Verificat / Checked	Verificator / Verifier	12.2011	Giuseppe Fioravanti

SUBCONTRACTANT / SUBCONTRACTOR		Data	Semnatura
Aprobat / Approved	Responsabil Subcontractant / Subcontractant Responsible	12.2011	A. Stanca - Dinulescu
Elaborat / Elaborated	Proiectant / Designer	12.2011	Catalin Alexandrescu

Reabilitarea liniei de cale ferată Brașov - Simeria, parte componentă a coridorului IV Pan European, pentru circulația trenurilor cu viteză maximă de 160 km/h, Tronsoanul: Brașov - Sighișoara  
Rehabilitation of the railway line Brașov - Simeria, component Part of the IV Pan-European Corridor, for the trains circulation with maximum speed of 160 km/h, Section: Brașov - Sighișoara

Denumire desen / Drawing Title:  
STATIA FELDIOARA TUNEL PIETONAL DETALII ARMARE VEDERE IN PLAN - FELDIOARA STATION PEDESTRIAN TUNNEL REINFORCEMENT DETAILS PLAN VIEW

Codificare / Codification System	Scara / Scale	LOT / LOT	Nr. / No
E A 5 1 0 1 E 0 7 P B C C 0 0 3 4 0 0 9 0	1:50		01/01