
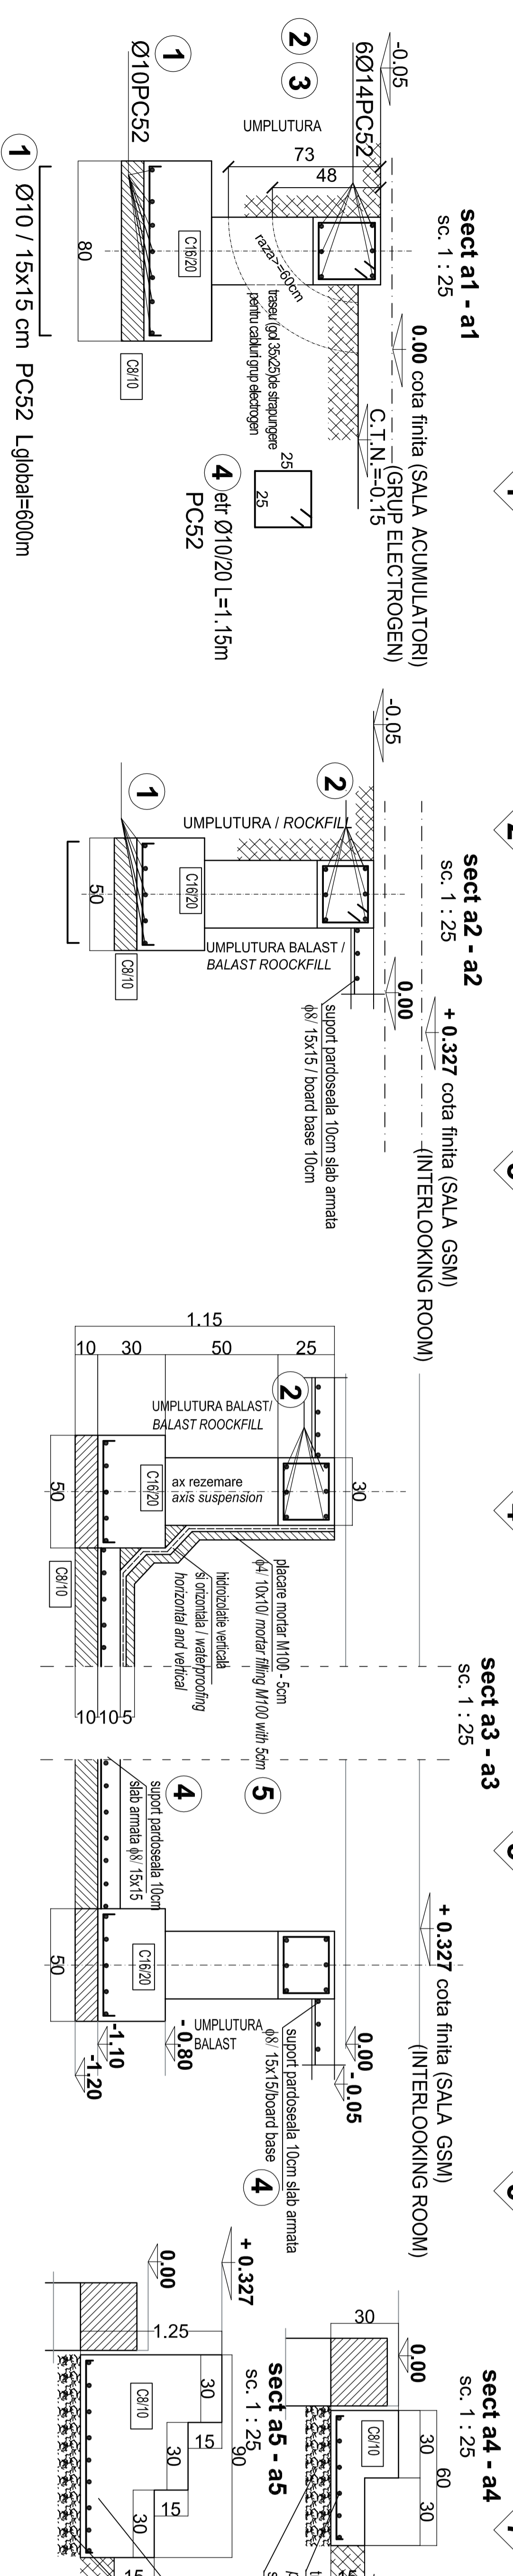


BETON ARMAT/ REINFORCED CONCRETE C16/20
 BETON SIMPLU / CONCRETE C8/10
 OTEL BETON / REINFORCING STEEL PC52
 MARCA MORTAR/ CLASS OF MORTAR M100

CLADIRE CONTAINER C.E. TIP /
 TYPICAL I.S. SHELTER BUILDING
 PLAN FUNDATII SI DETALII SCARA 1:50
 FOUNDATION PLAN AND DETAILS SCALE 1:50

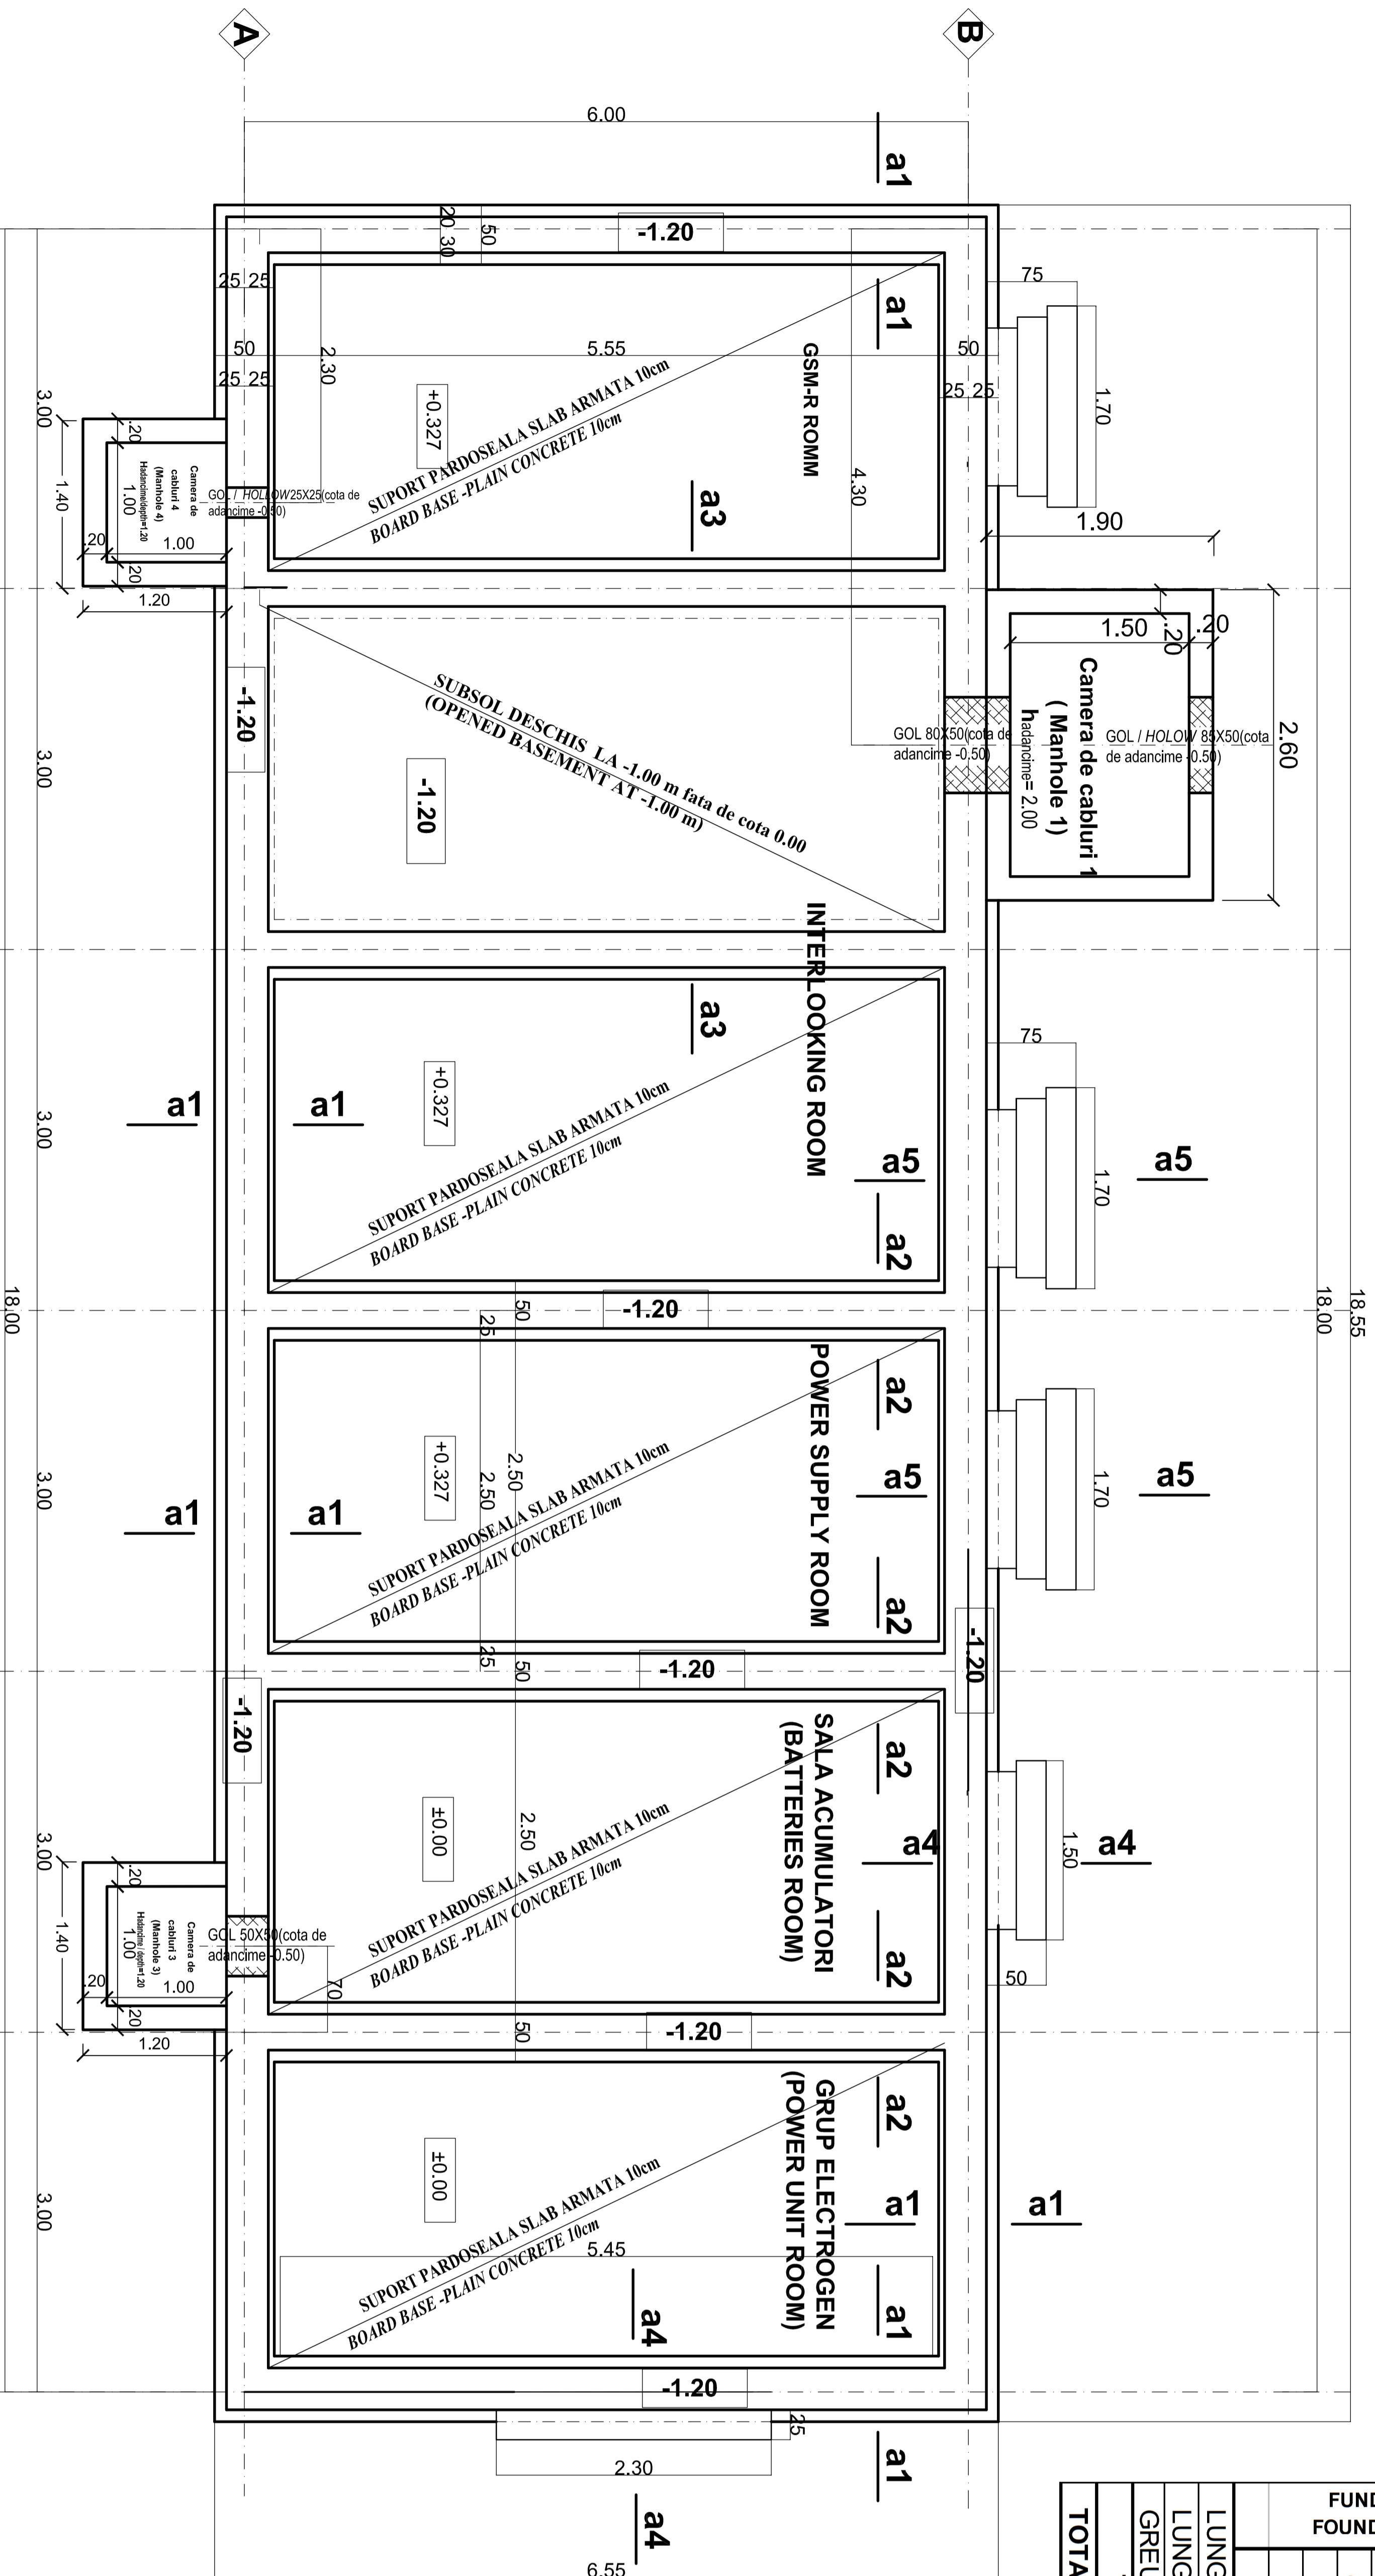

EXTRAS ARMATURA

ELEM.	MARCA	DIAM.	NR. BARA BUC.	LUNG. -m-	LUNGIMI / DIAMETRE	
					ø8	PC52 ø10
1	10	1	485.00		296.1	
2	14	42	7.05		240.0	
3	14	24	10.00			
4	10	430	1.15			
TOTAL					494.5	
LUNGIME / DIAMETRE					0.0	536.1
LUNGIME / m / DIAMETRE					0.395	0.617
GREUTATE / DIAMETRE					0.0	647.6
TOTAL					605.0	648.0
TOTAL GENERAL (PC52) Kg :					1253.0	

5 ø8 15x15 PC52 S=110 m² 5.52kg/m² x 110m²=607.6kg
 6 ø4 10x10 PC52 S=30 m² 1.98kg/m² x 30m²=59.4kg

NOTA / NOTE:

- LA ACHIZITIONAREA CONTAINARELOR SE VOR DEFINITIVA SISTEMUL ACESTORA DE PRINDERE CU FUNDATIILE / WHEN PURCHASING THE CONTAINERS, THE FASTENING SYSTEM WILL BE FINALIZED
- IN CAZUL CONTINARULUI UNDE SE VA MONTA GRUPUL ELECTROGEN, SUPORTUL PARDOSELII DE 10CM SE VA ARMA CU PLASA DUBLA ø 8 / 15X15 / IN THE CASE OF THE CONTAINER WHERE THE POWER UNIT ROOM WILL BE FITTED, THE SUPPORT OF THE 10CM THICK FLOOR WILL BE REINFORCED WITH DOUBLE ø 8 15X15

ROMANIA
 ROMANIAN GOVERNMENT
 EUROPEAN UNION FINANCED PROJECT
 C.N.C.F. "C.F.R." - S.A.

CLIENT / CLIENT

CONSULTANT / CONSULTANT

CONSULTANT / SUBCONTRACTOR

CLIENT / CLIENT

CONSULTANT / CONSULTANT

 OBERMEYER BERATEN GmbH
 Consulting Engineers

APPROVAL	RESPONSIBILITY / SUBCONTRACTANT	DATE	SIGNATURE
Approved	Subcontractor Responsible	12.2011	[Signature]
Approved	Project manager	12.2011	[Signature]
Approved	Coordinator/Section 1	12.2011	[Signature]
Approved	Section 1 Coordinator	12.2011	[Signature]
Verified	Expert Verifier	12.2011	[Signature]
Checked	Checking Expert	12.2011	[Signature]

REABILITAREA LINIEI DE CALE FERATA BRASOV - SIMERIA, PARTE COMPONENTA A CORIDORULUI IV Pan European, pentru circulatia trenurilor cu viteza maxima de 160 km/h.
TRONSONUL : Brasov - Sibiu
 Rehabilitation of the railway line Brasov - Simeria, component Part of the IV Pan-European Corridor, for the trains circulation with maximum speed of 160 km/h.
Section : Brasov - Sighisoara
Denumire desen / Drawing Title :
 Stata ct FELDIOARA / FELDIOARA Railway station
Plan fundatii si detalii - Cladire container C.E. tip / Foundation plan and details - Typical I.S. shelter building
 Codificare / Certification System
 Scara / Scale 1:50
 LOT / LOT
 Nr. / No 01/10